









6

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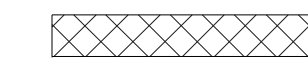
D

C

B

A


**DETENTION SYMBOL LEGEND:**




PRIMARY SECURITY: CONCRETE OR MASONRY WALL FULL HEIGHT TO STRUCTURE ABOVE. FULLY GROUTED CELLS WITH #4 REINFORCING BAR VERTICALLY EVERY 8". DOWELLED TO FLOOR SLAB. THIS SECURITY REINFORCING IS IN ADDITION TO ANY STRUCTURAL REQUIREMENTS.



SECONDARY SECURITY: CONCRETE OR MASONRY WALL TO STRUCTURE ABOVE. NOT FULLY GROUTED AND NO SECURITY REINFORCING NECESSARY.

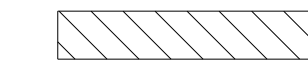

CONCRETE OR MASONRY WALL. NOT FULLY GROUTED AND NO SECURITY REINFORCING NECESSARY.

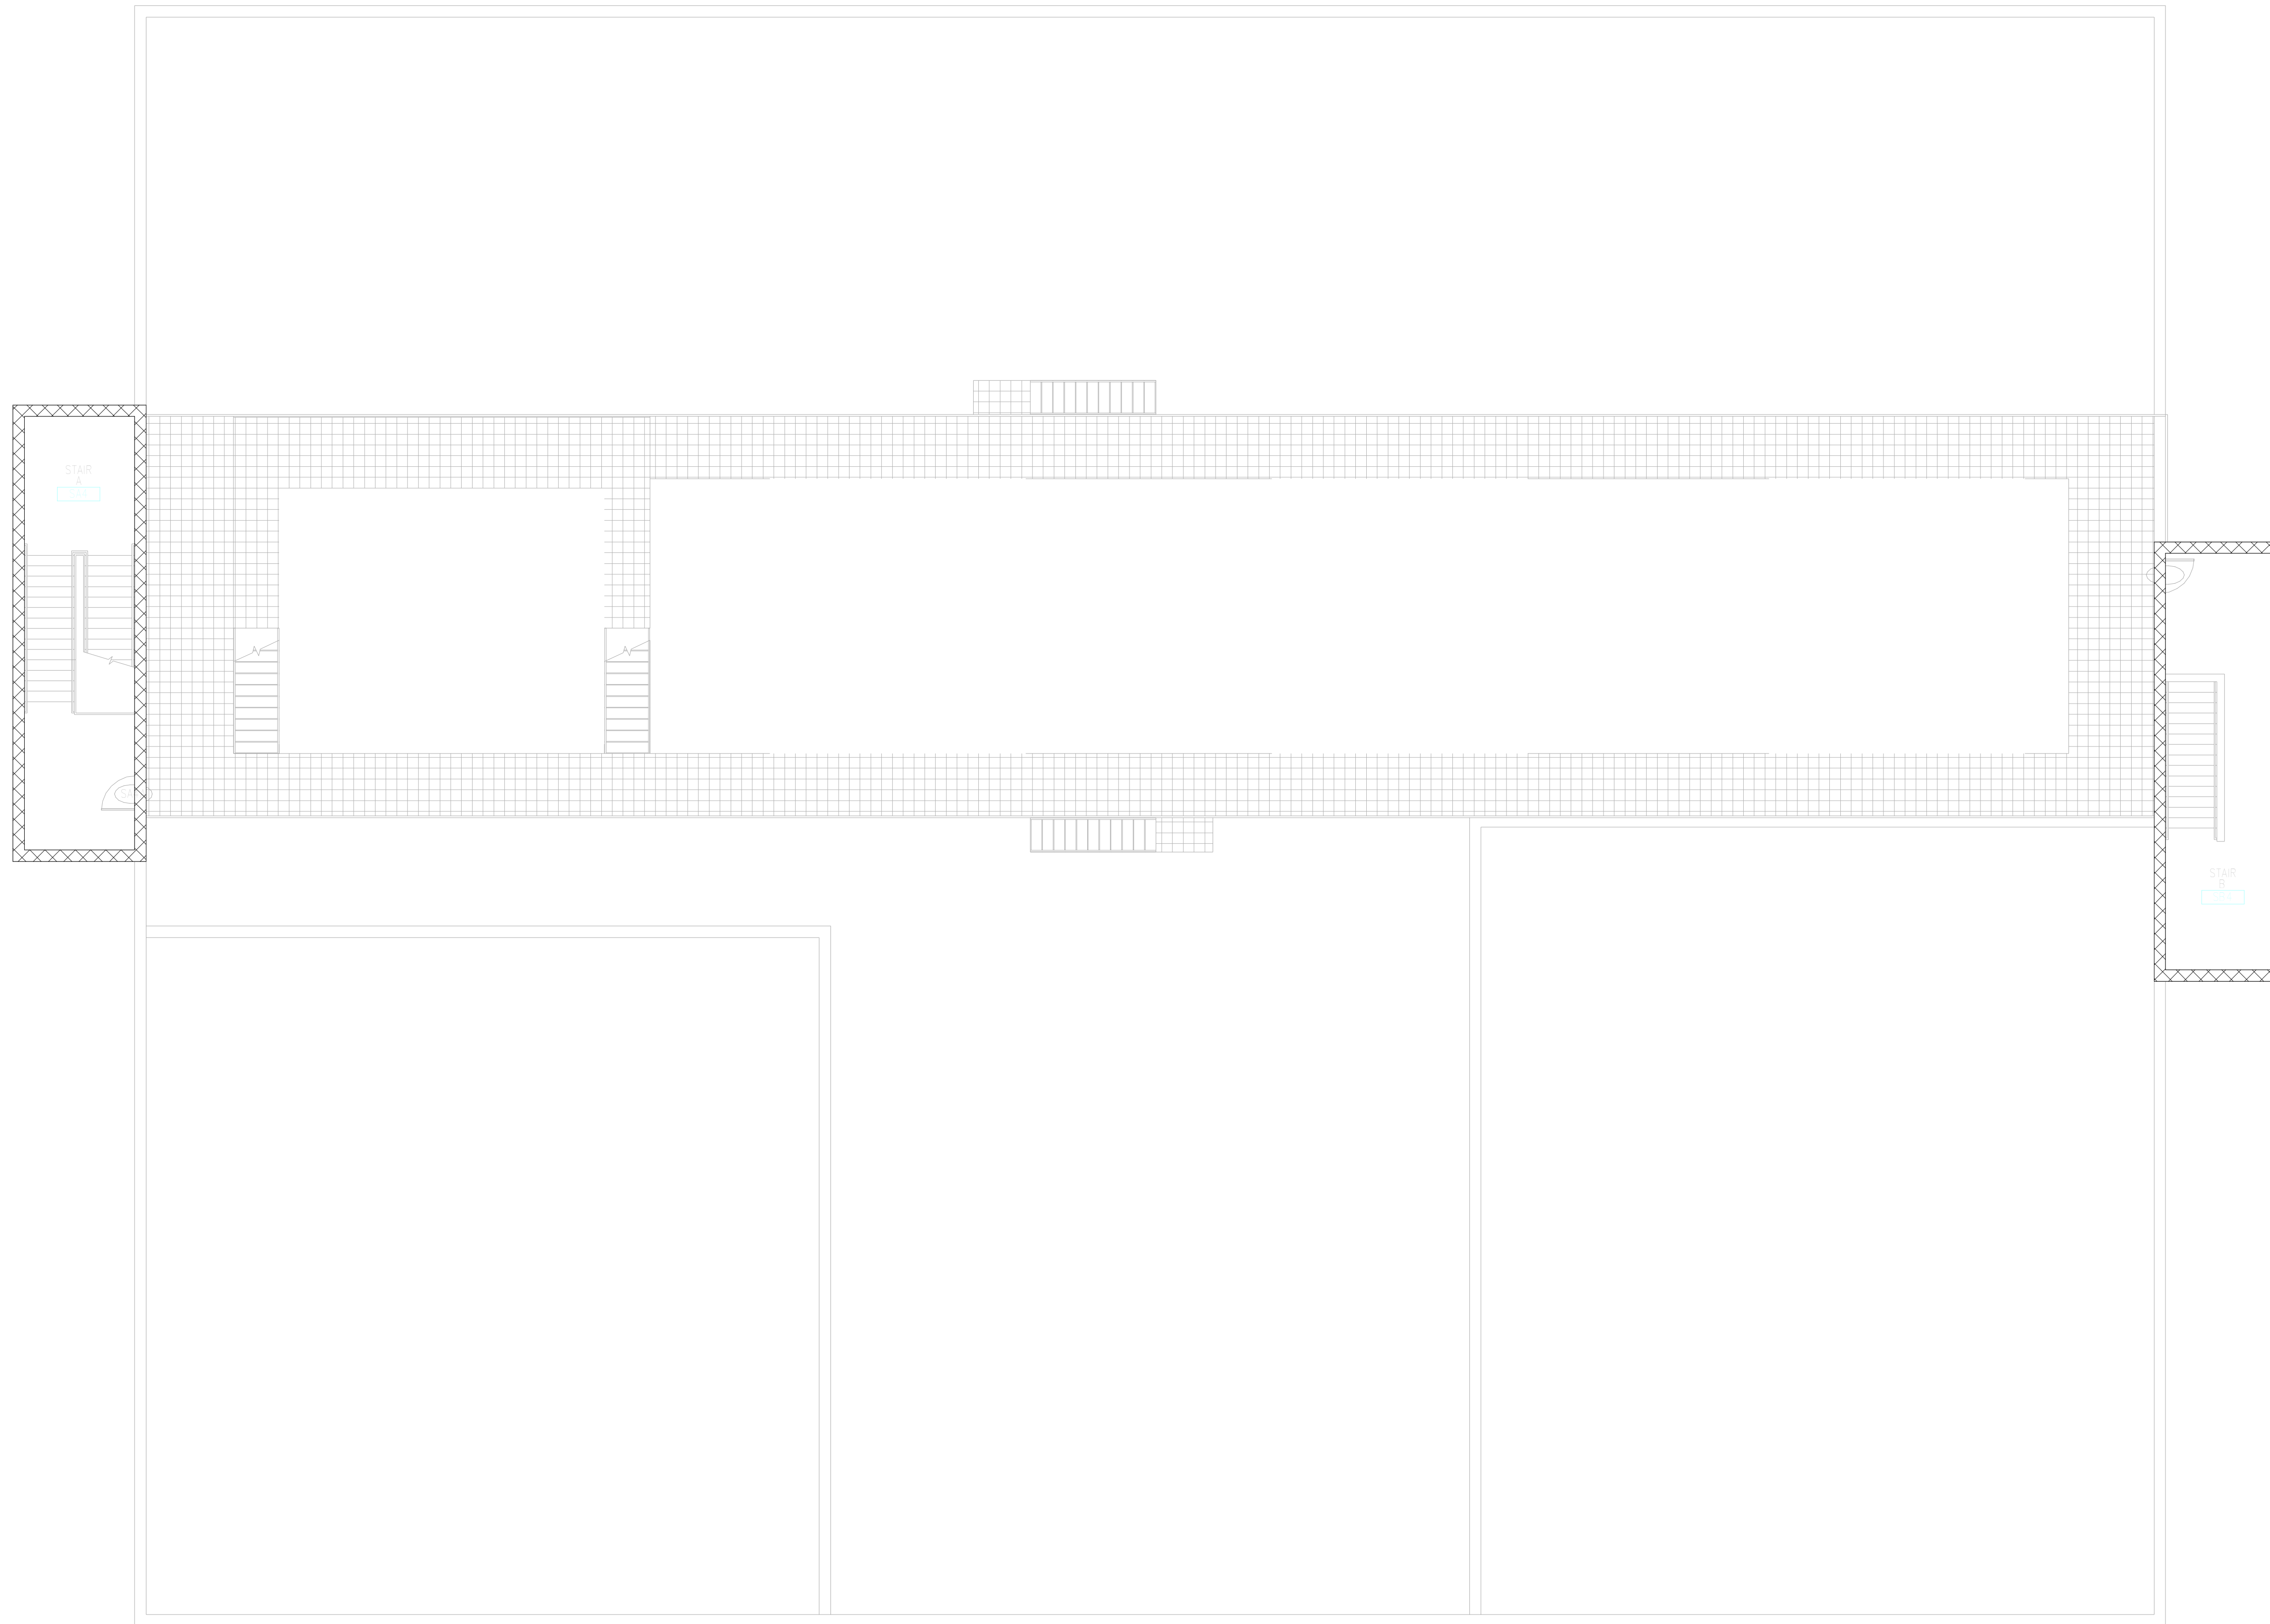

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Pinellas County  
**Upgrade Jail Campus Infrastructure  
Phase I Design Criteria**  
114400 North 49th Street  
Clearwater, FL.

SEAL

PRELIMINARY DOCUMENTS  
NOT FOR CONSTRUCTION

KEY PLAN

SCALE

As indicated

No.	Description	Date

**REVISIONS**

DRAWN BY \_\_\_\_\_ CAC  
APPROVED BY \_\_\_\_\_ JMP  
CHECKED BY \_\_\_\_\_ CA  
DATE \_\_\_\_\_ 3/19/2014

**TITLE**

**CATWALK WALL  
TYPE -  
DETENTION -  
INFAS BLDG**

PROJECT NO. 50057109

**QD-104**

SHEET NO.

**1 CATWALK - DETENTION**  
Scale: 1/8" = 1'-0"

F

E

D


C

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A

DOOR SCHEDULE - CENTRAL ENERGY PLANT - FIRST FLOOR											
DOOR NUMBER	DOOR TYPE	DOOR SIZE			MATERIAL	FRAME		LOCK TYPE	FIRE RATING LABEL	GLAZING	REMARKS
		WIDTH	HEIGHT	THICK		FRAME TYPE	MATERIAL				
		S41A	C	3'-0"		7'-0"	2"				
S41B	C	3'-0"	7'-0"	2"	DHM	2	DHM	300-S	45 MIN	SG-2F	
S81A	C	3'-0"	7'-0"	2"	DHM	2	DHM	300-S	45 MIN	SG-2F	
S81B	C	3'-0"	7'-0"	2"	DHM	2	DHM	300-S	45 MIN	SG-2F	
101A	(2)A	(2) 3'-0"	7'-0"	2"	DHM	2	DHM	380-A			
105A	D	5'-0"	7'-0"	2"	DHM	3	DHM	316S			DOOR SIZE GIVEN IS CLEAR OPENING
105B	D	5'-0"	7'-0"	2"	DHM	3	DHM	316A			DOOR SIZE GIVEN IS CLEAR OPENING
106A	C	4'-0"	7'-0"	2"	DHM	1	DHM	120-S	45 MIN	SG-2F	
106B	C	3'-0"	7'-0"	2"	DHM	1	DHM	120-S	45 MIN	SG-2F	
110A	C	3'-0"	7'-0"	2"	DHM	1	DHM	120-S			
116B	C	3'-0"	7'-0"	2"	DHM	1	DHM	120-S			
122B	C	3'-0"	7'-0"	2"	DHM	1	DHM	120-S			
134B	A	4'-0"	7'-0"	2"	DSS	1	DSS	120-S			
137A	B	3'-0"	7'-0"	2"	DHM	1	DHM	120-S			
137B	B	3'-0"	7'-0"	2"	DHM	1	DHM	120-S	45 MIN	SG-2F	
140A	A	3'-0"	7'-0"	2"	DHM	2	DHM	500	45 MIN		
141A	D	5'-0"	7'-0"	2"	DHM	3	DHM	316S			DOOR SIZE GIVEN IS CLEAR OPENING


DOOR SCHEDULE - CENTRAL ENERGY PLANT - SECOND FLOOR											
DOOR NUMBER	DOOR TYPE	DOOR SIZE			MATERIAL	FRAME		LOCK TYPE	FIRE RATING LABEL	GLAZING	REMARKS
		WIDTH	HEIGHT	THICK		FRAME TYPE	MATERIAL				
		S42A	C	3'-0"		7'-0"	2"				
S82A	C	3'-0"	7'-0"	2"	DHM	2	DHM	300-S	45 MIN	SG-2F	
214A	B	3'-0"	7'-0"	2"	DHM	1	DHM	120-M			
217A	A	5'-0"	7'-0"	2"	DHM	2	DHM	70			
221A	D	5'-0"	7'-0"	2"	DHM	3	DHM	316S			DOOR SIZE GIVEN IS CLEAR OPENING
222A	D	5'-0"	7'-0"	2"	DHM	3	DHM	316S			DOOR SIZE GIVEN IS CLEAR OPENING
233A	A	3'-0"	7'-0"	2"	DHM	2	DHM	316S			

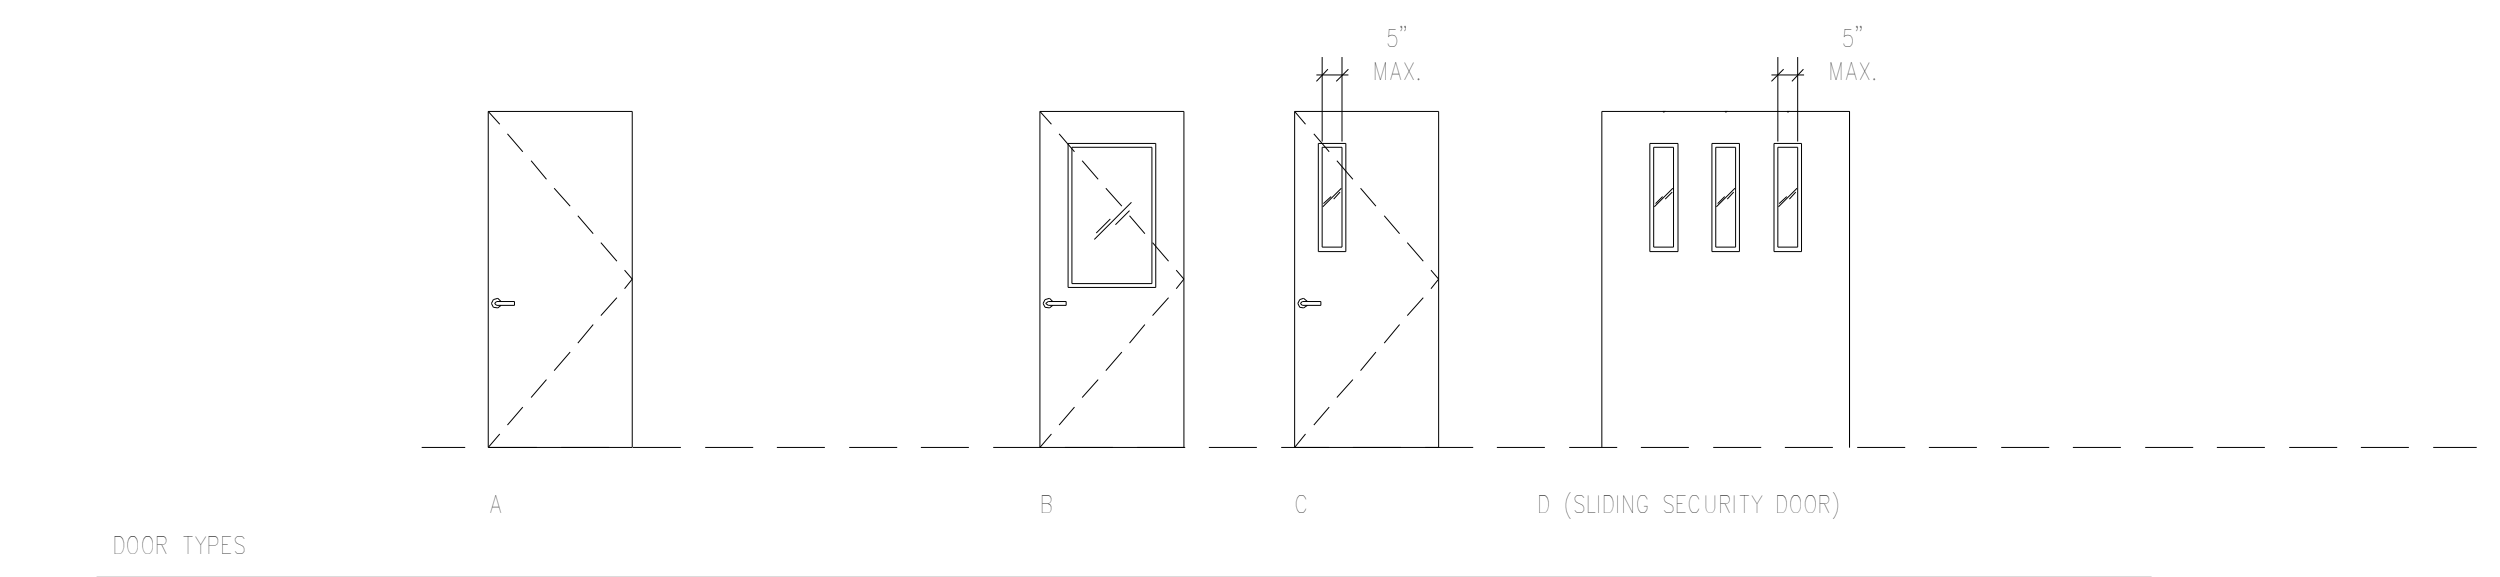

DOOR SCHEDULE - CENTRAL ENERGY PLANT - THIRD FLOOR											
DOOR NUMBER	DOOR TYPE	DOOR SIZE			MATERIAL	FRAME		LOCK TYPE	FIRE RATING LABEL	GLAZING	REMARKS
		WIDTH	HEIGHT	THICK		FRAME TYPE	MATERIAL				
		S43A	C	3'-0"		7'-0"	2"				
S83A	C	3'-0"	7'-0"	2"	DHM	2	DHM	300-S	45 MIN	SG-2F	
S83B	A	3'-0"	7'-0"	2"	DHM	2	DHM	70	45 MIN		
304A	C	3'-0"	7'-0"	2"	DHM	1	DHM	120-M			
304B	B	3'-0"	7'-0"	2"	DHM	1	DHM	120-M			
307A	B	3'-0"	7'-0"	2"	DHM	2	DHM	300-S			
307B	C	3'-0"	7'-0"	2"	DHM	2	DHM	70			
311B	(2) A	3'-0"	7'-0"	2"	DHM	2	DHM	70			
311C	(2) A	3'-0"	7'-0"	2"	DHM	2	DHM	380-A			

DOOR SCHEDULE - CONNECTOR ADDITION/RENOVATION - SECOND FLOOR											
DOOR NUMBER	DOOR TYPE	DOOR SIZE			MATERIAL	FRAME		LOCK TYPE	FIRE RATING LABEL	GLAZING	REMARKS
		WIDTH	HEIGHT	THICK		FRAME TYPE	MATERIAL				
		211A	B	3'-0"		7'-0"	2"				
211B	B	3'-0"	7'-0"	2"	DHM	1	DHM	120-M			
211C	C	3'-0"	7'-0"	2"	DHM	1	DHM	120-M			
211D	B	3'-0"	7'-0"	2"	DHM	1	DHM	120-M			
211E	C	3'-0"	7'-0"	2"	DHM	1	DHM	120-M			NEW DOOR AND FRAME IN EXISTING WALL
211F	(2)B	3'-0"	7'-0"	2"	DHM	6	DHM	300-S			

DOOR SCHEDULE - ELEVATOR ADDITION - FIRST & SECOND FLOORS											
DOOR NUMBER	DOOR TYPE	DOOR SIZE			MATERIAL	FRAME		HARDWARE SET	FIRE RATING LABEL	GLAZING	REMARKS
		WIDTH	HEIGHT	THICK		FRAME TYPE	MATERIAL				
		140A	C	3'-0"		7'-0"	2"				
140B	C	3'-0"	7'-0"	2"	DHM	4	DHM	120-S	45 MIN	SG-2F	
140D	D	5'-0"	7'-0"	2"	DHM	5	DHM	316S			NEW DOOR AND FRAME IN EXISTING WALL. CLEAR DOOR OPENING GIVEN.

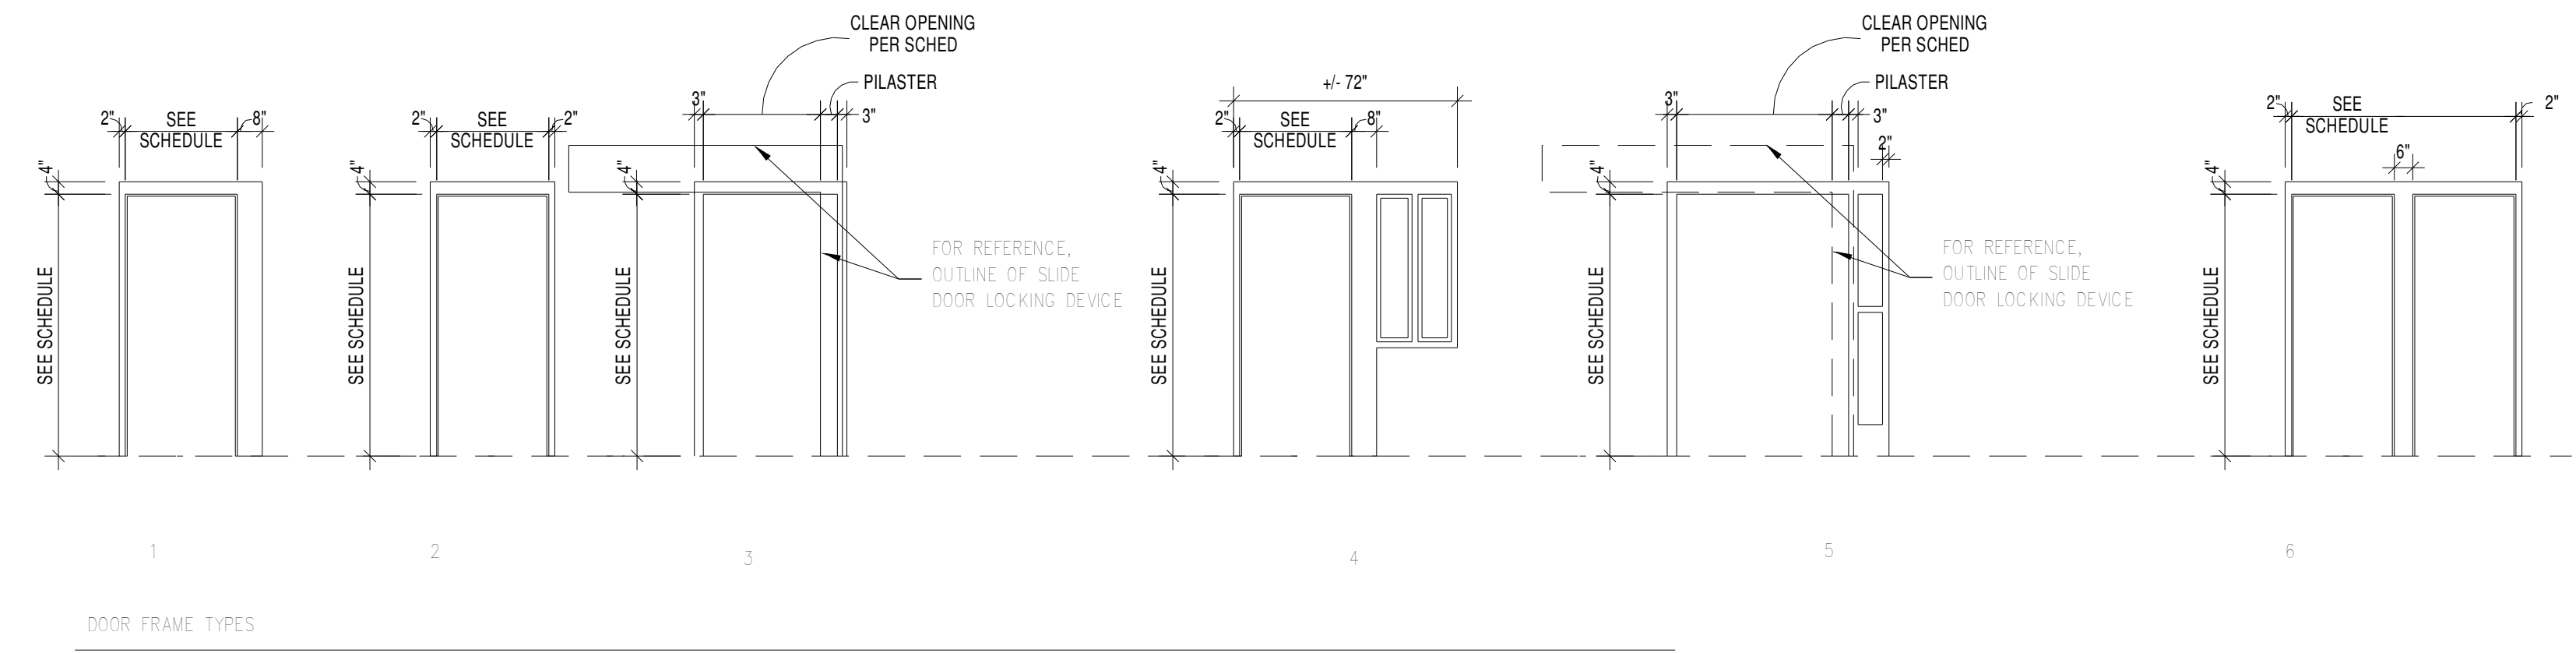

GENERAL DOOR/FRAE NOTES:

- REFER TO SECTION 11 19 53-DETENTION HARDWARE.
- LOCK TYPE IS DEFINED IN 11 19 53.
- ALTHOUGH HARDWARE SETS ARE NOT INDICATED FOR OPENINGS, ALL DOORS SHALL BE PROVIDED WITH ALL NECESSARY AND NORMAL HARDWARE AS SPECIFIED IN 11 19 53.
- ALL FRAMES SHALL BE CAULKED CONTINUOUSLY WITH SECURITY JOINT SEALANT TO THE WALL ON BOTH SIDES.
- DOOR SCHEDULED TO HAVE A FIRE RATING LABEL SHALL HAVE HARDWARE SETS THAT INCLUDE NECESSARY ITEMS FOR A LABEL.
- EXTERIOR DOORS SHALL HAVE FLORIDA PRODUCT APPROVAL TO MATCH WIND DESIGN CRITERIA ASSOCIATED WITH BUILDING.
- SEE SHEET QD-020 FOR DETAILS.

DOOR LEGEND:

DHM DETENTION HOLLOW METAL SECTION 11 19 13



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SEAL

PRELIMINARY DOCUMENTS  
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KEY PLAN

SCALE

1/4" = 1'-0"

No.	Description	Date

REVISIONS

DRAWN BY \_\_\_\_\_ Author

APPROVED BY \_\_\_\_\_ Approver

CHECKED BY \_\_\_\_\_ Checker

DATE \_\_\_\_\_ 3/19/2014

TITLE

DOOR SCHEDULE  
 - DETENTION -  
 INFAS BLDG

PROJECT NO. \_\_\_\_\_ 50057109

QD-400

SHEET NO.



INTERIOR WINDOW SCHEDULE - CENTRAL ENERGY PLANT




MARK	LOCATION	SIZE		SILL HEIGHT	TYPE	MATERIAL	GLAZING TYPE	LABEL
		WIDTH	HEIGHT					
S13	FIRST FLOOR - 137	3'-6"	4'-0"	3'-4"	SW-05	DHM	SG-2F	Y
S14	FIRST FLOOR - 137	9'-6"	4'-0"	3'-4"	SW-06	DHM	SG-2F	Y
S15	FIRST FLOOR - 137	6'-4"	4'-0"	3'-4"	SW-07	DHM	SG-2F	Y
S16	FIRST FLOOR - 137	5'-4"	4'-0"	3'-4"	SW-08	DHM	SG-2F	Y
S17	FIRST FLOOR - 137	9'-0"	4'-0"	3'-4"	SW-09	DHM	SG-2F	Y
S18	FIRST FLOOR - 137	5'-4"	4'-0"	3'-4"	SW-06	DHM	SG-2F	Y
S19	FIRST FLOOR - 137	3'-4"	4'-0"	3'-4"	SW-10	DHM	SG-2F	Y
S26	SECOND FLOOR - 214	4'-8"	4'-0"	3'-4"	SW-04	DHM	SG-2F	Y
S27	SECOND FLOOR - 214	3'-4"	4'-0"	3'-4"	SW-14	DHM	SG-2F	Y
S28	SECOND FLOOR - 214	11'-0"	4'-0"	3'-4"	SW-15	DHM	SG-2F	Y
S29	SECOND FLOOR - 214	5'-0"	4'-0"	3'-4"	SW-16	DHM	SG-2F	Y
S30	SECOND FLOOR - 214	16'-0"	4'-0"	3'-4"	SW-17	DHM	SG-2F	Y
S31	SECOND FLOOR - 214	5'-0"	4'-0"	3'-4"	SW-18	DHM	SG-2F	Y
S32	SECOND FLOOR - 214	4'-0"	4'-0"	3'-4"	SW-18	DHM	SG-2F	Y

GENERAL NOTES

1. ALL FRAMES SHALL BE CAULKED CONTINUOUSLY WITH SECURITY JOINT SEALANT TO THE WALL ON BOTH SIDES.
2. EXTERIOR WINDOWS SHALL HAVE FLORIDA PRODUCT APPROVAL TO MATCH WIND DESIGN CRITERIA ASSOCIATED WITH BUILDING.
3. SEE SECTION 11 19 43-RETENTION ENCLOSURES FOR WOVEN ROOF MESH SYSTEMS.
4. SEE 00-20 FOR DETAILS.

DOOR LEGEND

DHM DETENTION HOLLOW METAL, SECTION 11 19 13.  
 HSW HURRICANE-SECURITY WINDOW SYSTEM, SECTION 11 19 13. ALL WINDOWS ARE BARRED.

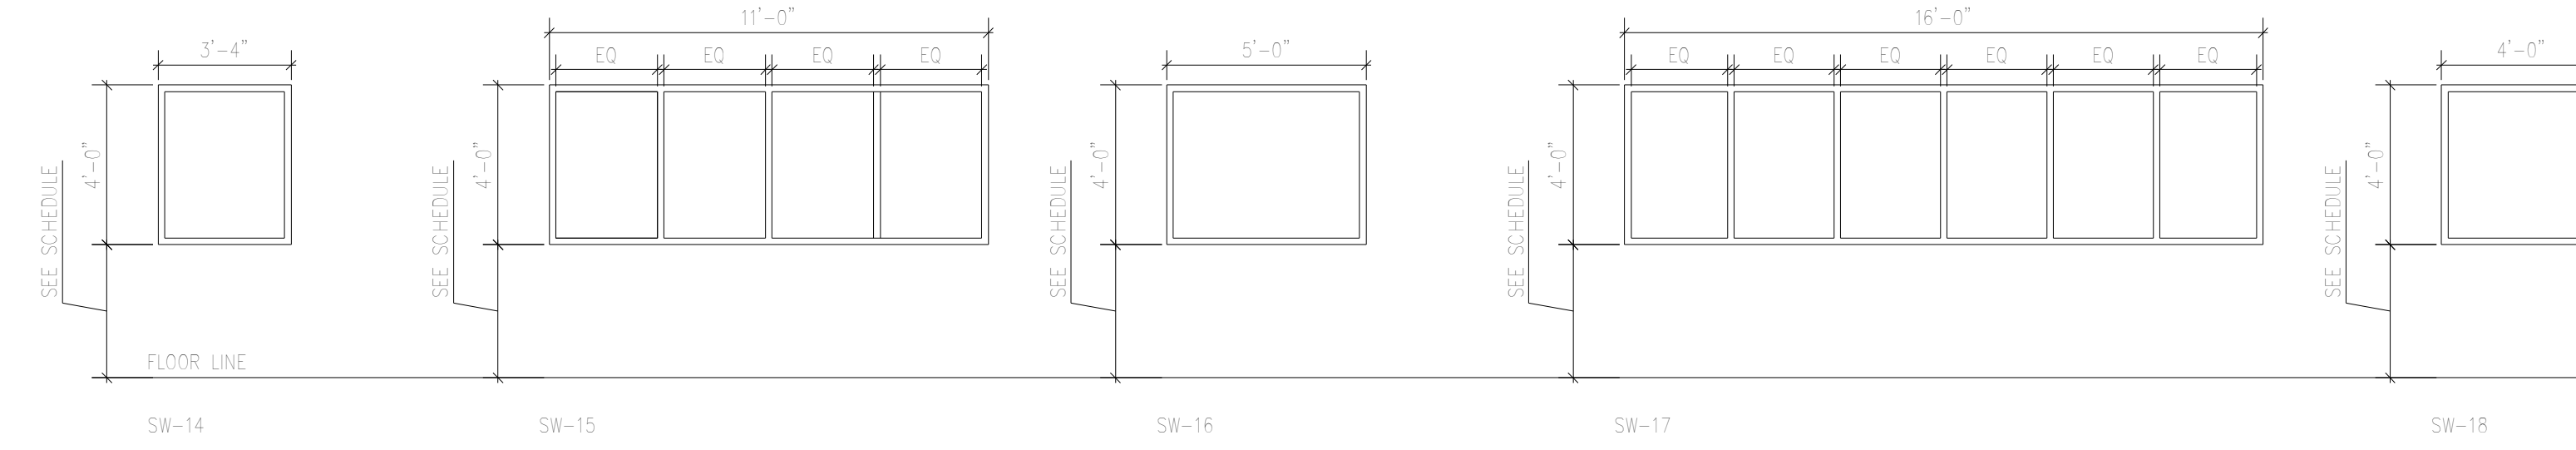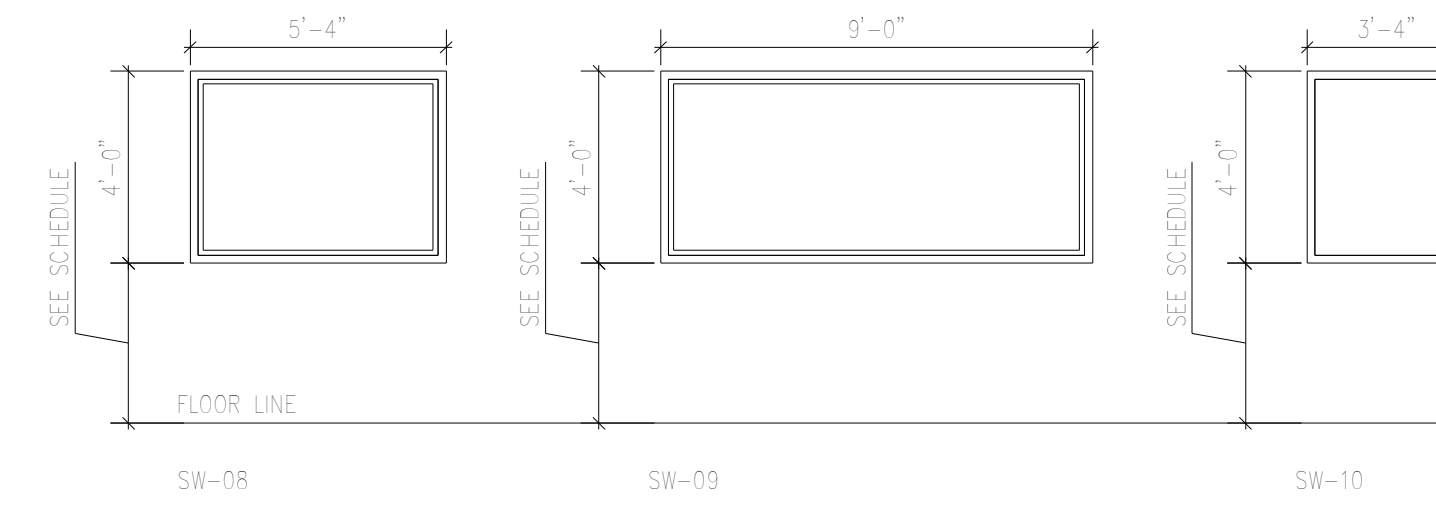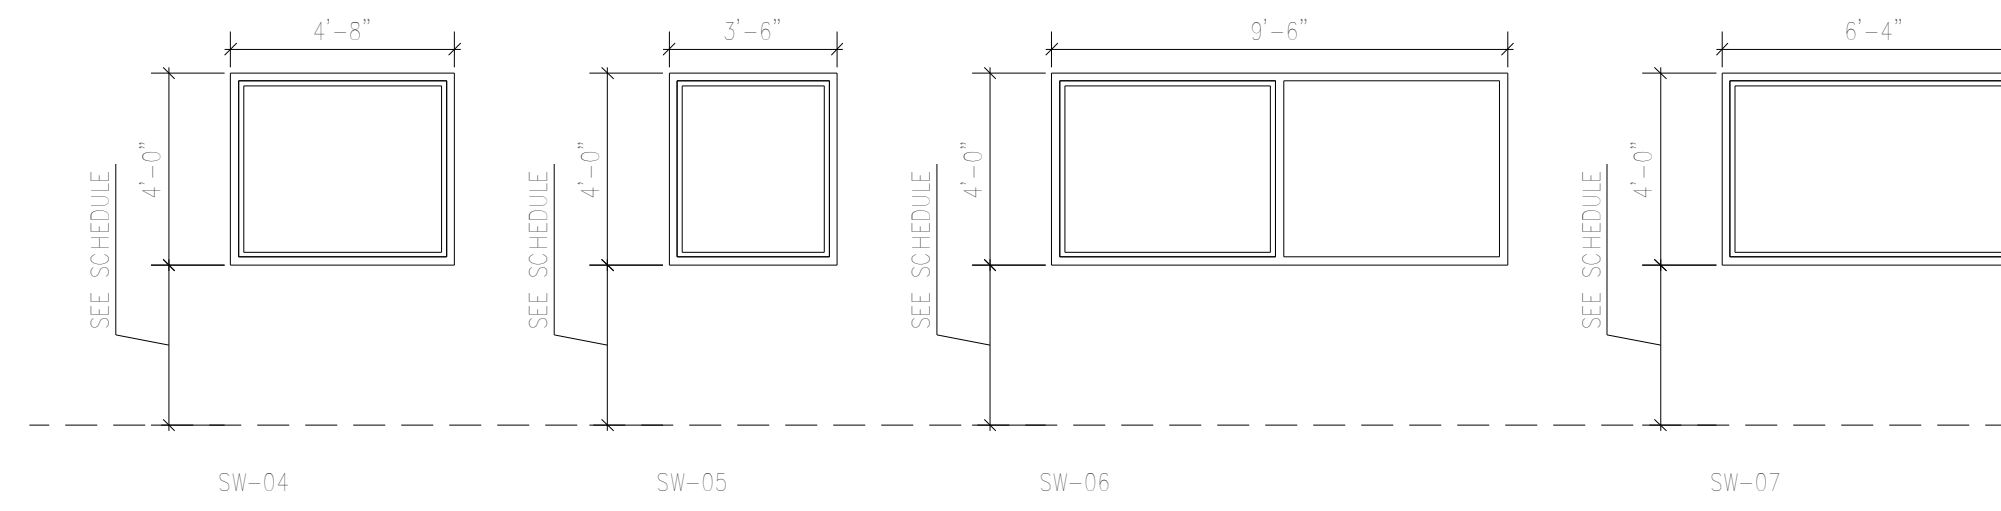

SEAL

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KEY PLAN

SCALE

1/4" = 1'-0"

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REVISIONS

DRAWN BY \_\_\_\_\_ Author  
 APPROVED BY \_\_\_\_\_ Approver  
 CHECKED BY \_\_\_\_\_ Checker  
 DATE \_\_\_\_\_ 3/19/2014

TITLE

WINDOW  
 SCHEDULE CONT.  
 - DETENTION -  
 INFAS BLDG

PROJECT NO. 50057109

QD-601

SHEET NO.